

INDEX OF DRAWINGS

- 1 - 3 COVER SHEET
- 2 - 3 GARAGE ADDITION MECHANICAL PLAN
- 3 - 3 LUBE AND TIRE MECHANICAL PLAN

MISSOURI DEPARTMENT OF TRANSPORTATION


SOUTHWEST DISTRICT CARBON MONOXIDE SYSTEMS

TWO LOCATIONS AT THE MODOT SITE
3025 EAST KEARNEY, SPRINGFIELD, MO.

CODE REQUIREMENTS

- BUILDING CODE - 2003 IBC
- MECHANICAL CODE - CURRENT IBC
- ELECTRICAL CODE - CURRENT N.E.C.

GREENE COUNTY

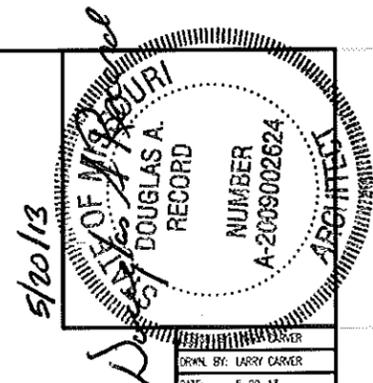


DRWN. BY: LARRY CARMER
DATE: 5-20-13

SOUTHWEST DISTRICT
Carbon Monoxide Systems
3025 East Kearney, Springfield, MO

MISSOURI DEPARTMENT
OF TRANSPORTATION
DIVISION OF GENERAL SERVICES
FACILITIES MANAGEMENT

COVER SHEET

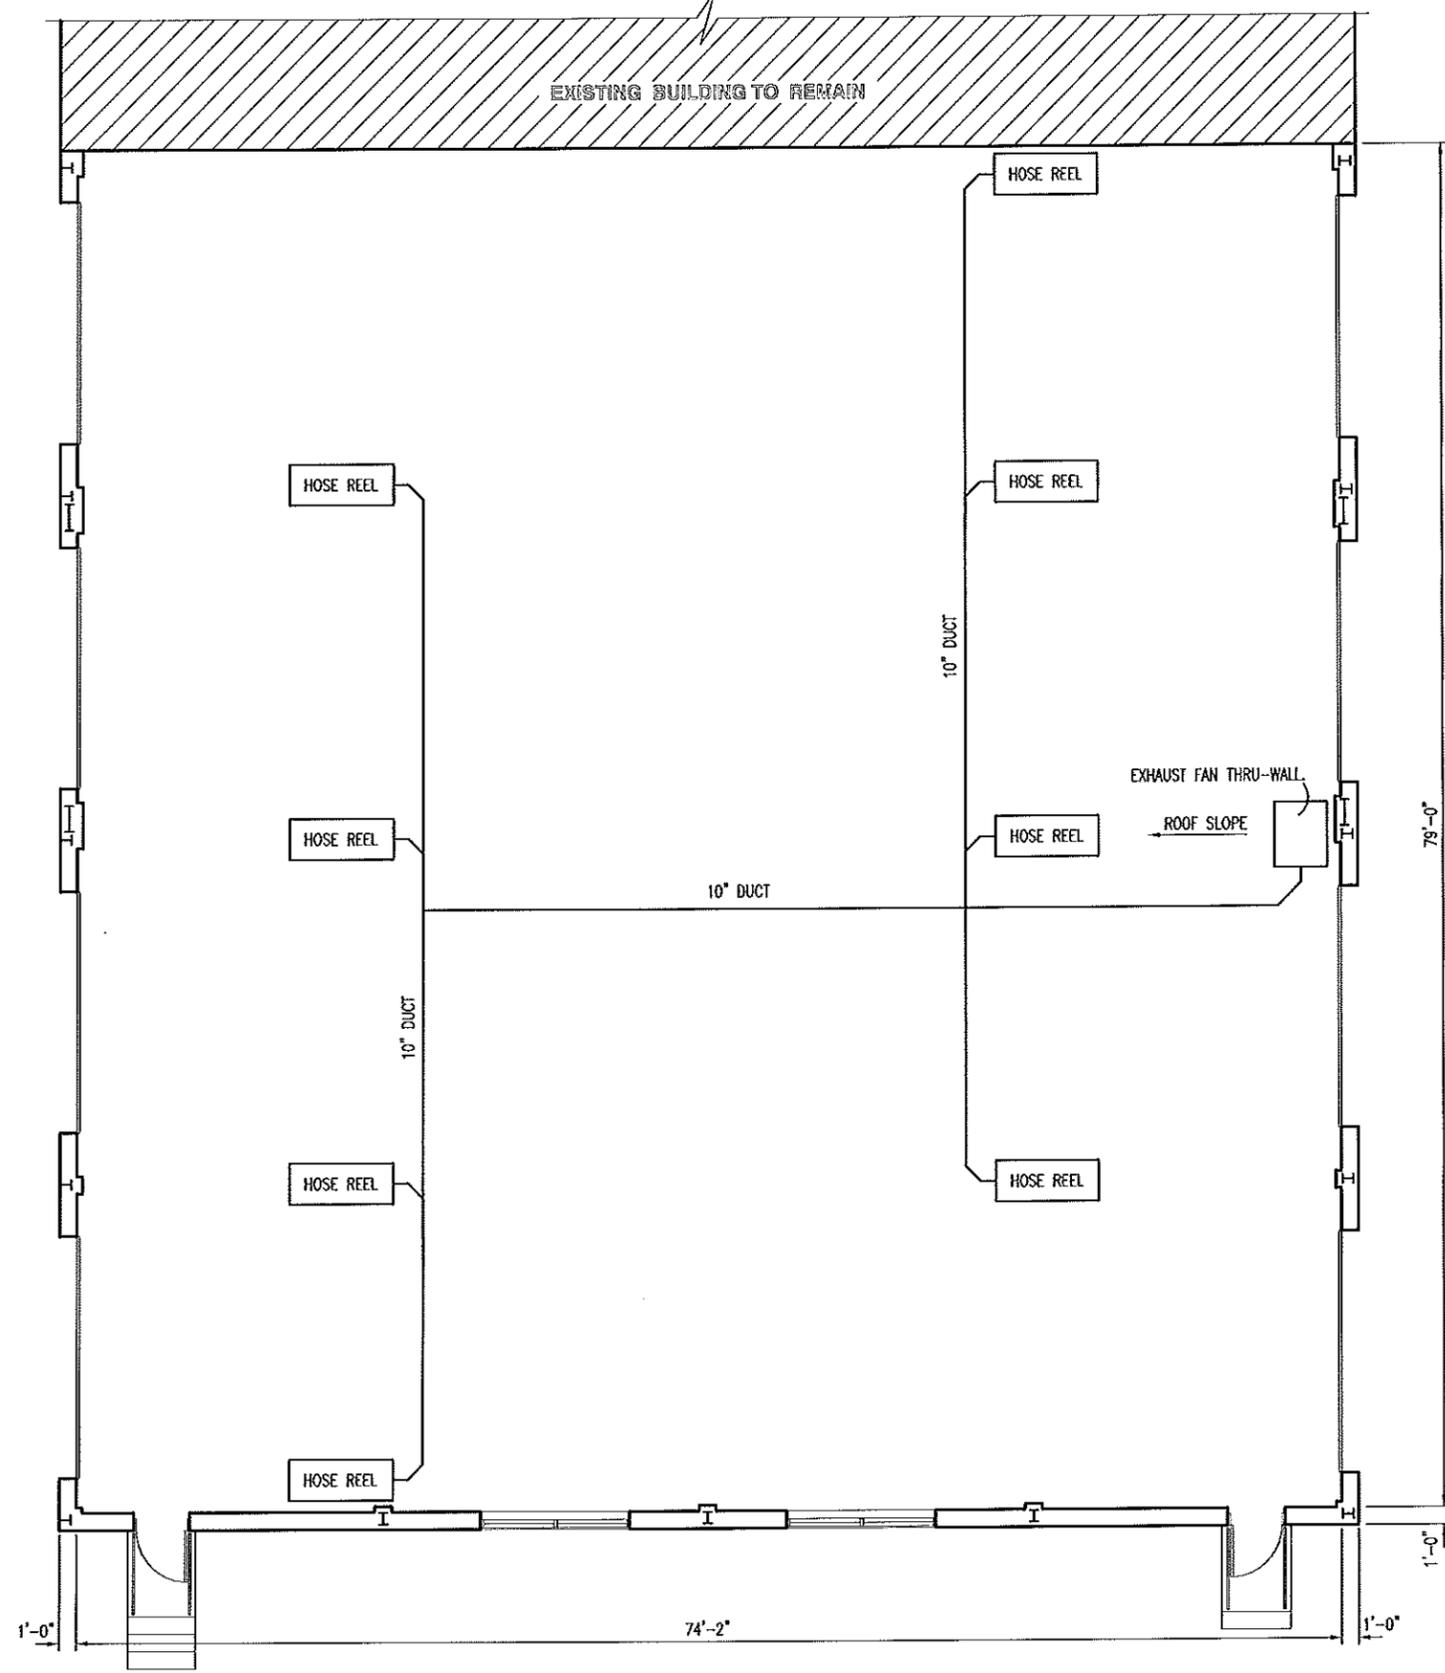

CONTRACTOR TO PROVIDE CARBON MONOXIDE SYSTEM EQUIPMENT EQUAL TO AIR TECHNOLOGIES, INC. AS THE FOLLOWING:

QUANTITY: PROVIDE EIGHT (8) SPRING EXHAUST HOSE REELS.

SEE SPECIFICATION FOR THE MAIN SERVICE BAY.

INCLUDES AND INSTALLATION OF SPIRAL DUCTING AND SUPPORTS FOR AN OPERABLE SYSTEM. COORDINATE INSTALLATION WITH MODOT PROVIDED ELECTRICIAN.

TOP OF MAINFRAME 23.32' A.F.F, 1/12 ROOF SLOPE.

5/20/13

Missouri ARCHITECT

DOUGLAS A. RECORD

NUMBER A-2009002624

MISSOURI ARCHITECTS ASSOCIATION

MISSOURI ARCHITECT

DOUGLAS A. RECORD

ARCHITECT


DATE: 5-20-13


SOUTHWEST DISTRICT
Carbon Monoxide Systems
3025 East Kearney, Springfield, MO

MISSOURI DEPARTMENT
OF TRANSPORTATION
DIVISION OF GENERAL SERVICES
FACILITIES MANAGEMENT

Garage Addition Mechanical Plan

GARAGE ADDITION
MECHANICAL PLAN
SCALE: 3/32" = 1'-0"

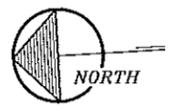

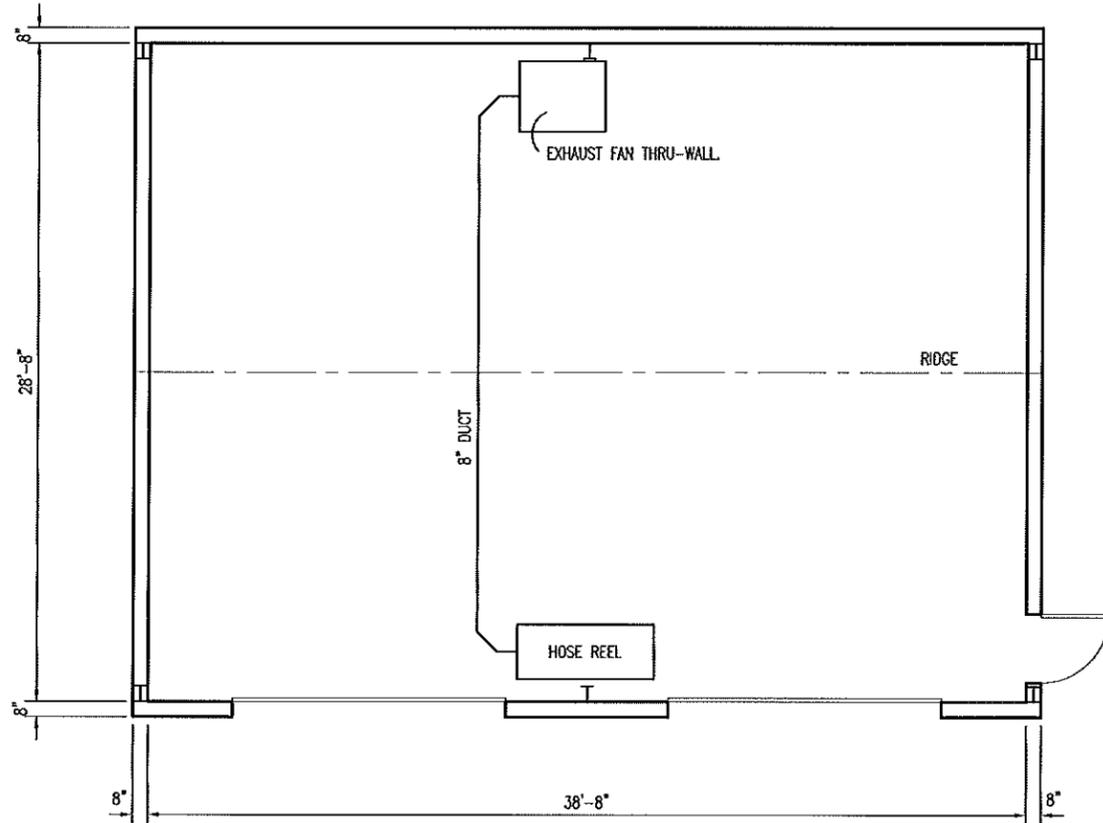

CONTRACTOR TO PROVIDE CARBON MONOXIDE SYSTEM EQUIPMENT EQUAL TO AIR TECHNOLOGIES, INC. AS THE FOLLOWING:

QUANTITY: PROVIDE ONE (1) SPRING EXHAUST HOSE REEL.


SEE SPECIFICATION FOR AUTO SHOP BAY.

INCLUDES AND INSTALLATION OF SPIRAL DUCTING AND SUPPORTS FOR AN OPERABLE SYSTEM. COORDINATE INSTALLATION WITH MODOT PROVIDED ELECTRICIAN.


EAVE HEIGHT: 14'-0", 1/12 ROOF SLOPE

A
3

LUBE AND TIRE
MECHANICAL PLAN
 SCALE: 1/8" = 1'-0"

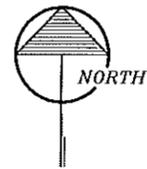

5/20/13

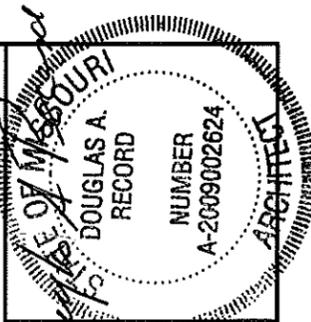

DRAWN BY: LARRY CARVER
 DATE: 5-20-13

SOUTHWEST DISTRICT
 Carbon Monoxide Systems
 3025 East Kearney, Springfield, MO

MISSOURI DEPARTMENT
 OF TRANSPORTATION
DIVISION OF GENERAL SERVICES
 FACILITIES MANAGEMENT

Lube and Tire Mechanical Plan